TOWN OF LUNENBURG


COMPLETE STREETS PROJECT - THREE LOCATIONS

IN THE TOWN OF LUNENBURG WORCESTER COUNTY THE COMMONWEALTH OF MASSACHUSETTS

INDEX

<u>IIIVDEX</u>	
SHEET NO.	DESCRIPTION
1	_ TITLE SHEET & INDEX
2	_ LEGEND, ABBREVIATIONS & GENERAL NOTES
3 - 5	_ GENERAL PLANS
6-8	_ CURB TIE AND GRADING PLANS
9	_ TRAFFIC SIGN SUMMARY
10	_ CONSTRUCTION DETAILS AND PAVEMENT NOTES
11-12	_ PEDESTRIAN CURB RAMP AND DRIVEWAY DETAILS

PROJECT:

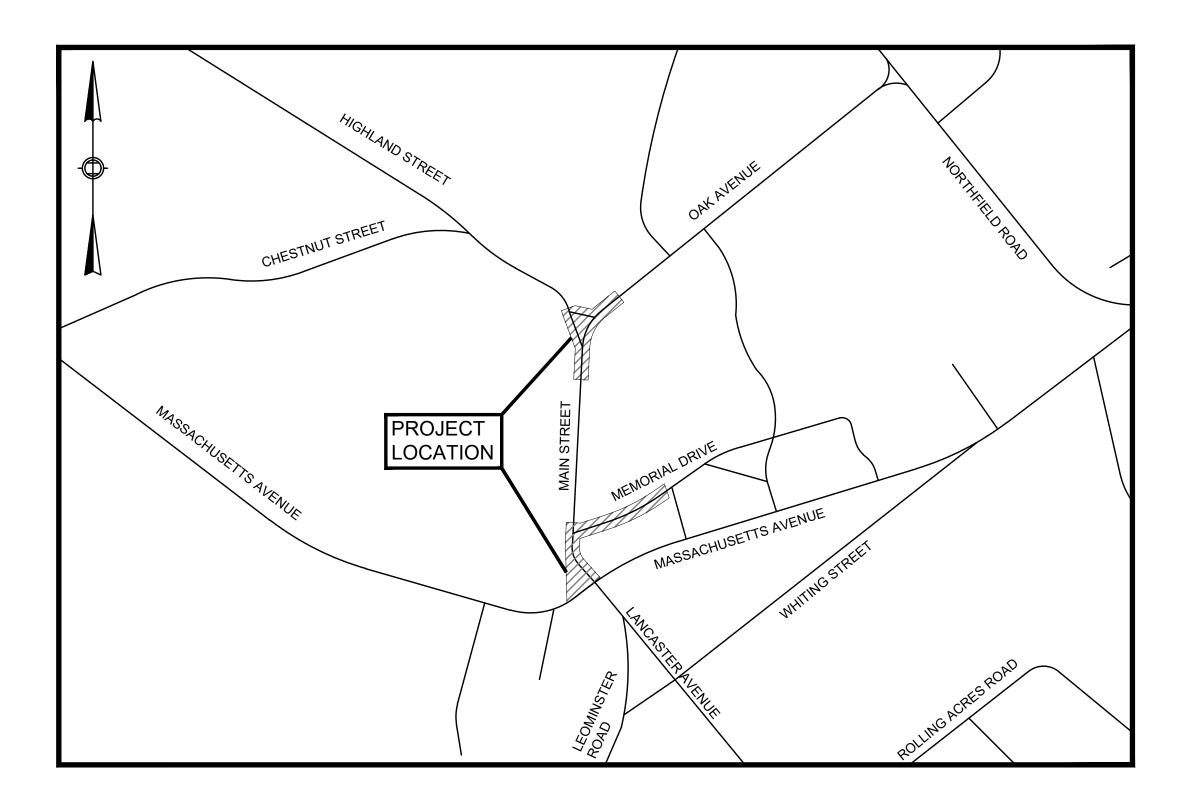

THESE PLANS ARE SUPPLEMENTED BY THE MASSDOT STANDARD SPECIFICATIONS FOR HIGHWAYS AND BRIDGES DATED 2021, THE OCTOBER 2017 CONSTRUCTION STANDARD DETAILS, THE 2015 OVERHEAD SIGNAL STRUCTURE AND FOUNDATION STANDARD DRAWINGS, MASSDOT TRAFFIC MANAGEMENT PLANS AND DETAIL DRAWINGS, THE LATEST MANUAL ON UNIFORM TRAFFIC CONTROL DEVICES FOR STREETS AND HIGHWAYS WITH MASSACHUSETTS AMENDMENTS, THE 1990 STANDARD DRAWINGS FOR SIGNS AND SUPPORTS, THE 1968 STANDARD DRAWINGS FOR TRAFFIC SIGNALS AND HIGHWAY LIGHTING, AND THE LATEST EDITION OF THE AMERICAN STANDARD FOR NURSERY STOCK, WILL GOVERN.

LOCUS MAP

SCALE

0 500 1000 1500 2000

(1" = 500')

CLIENT:

TOWN OF LUNENBURG

17 MAIN STREET LUNENBURG, MA 01642 PHONE: 978-582-4144 COMPLETE STREETS PROJECT
THREE LOCATIONS
LUNENBURG, MA

PREPARED BY:

WIREPARED BY:

ENGINEERING

300 TRADECENTER, SUITE 5580 WOBURN, MA 01801 T: 781-933-4800

F: 781-933-4801

	NO.	DATE	REVISION	SCALE:	AS NOTED
				DATE:	MARCH 202
				WTE PROJ. NO:	20-019.01
				DESIGNED BY:	KMC
PROFESSIONAL CIVIL ENGINEER FOR WORLDTECH ENGINEERING, LLC				CHECKED BY:	TFQ

TITLE SHEET & INDEX

DRAWING TITLE:

1 of 12

SHEET NO.

GENERAL SYMBOLS **EXISTING** PROPOSED DESCRIPTION **⊟** JB ■ JB JERSEY BARRIER ON BRIDGE OR JERSEY BARRIER Ш ⊕ Ш СВ CATCH BASIN CATCH BASIN CURB INLET ⊕ FP FLAG POLE G GP G GP GAS PUMP □ MB \square MB MAIL BOX **POST SQUARE** POST CIRCULAR O SP STEEL POLE ⊕ WELL ⊕ WELL WELL - EHH EHH ELECTRIC HANDHOLE 0 FENCE GATE POST o GG O GG GAS GATE ◆ BHL # BHL # **BORING HOLE** → MW # → MW # MONITORING WELL ■ TP # ■ TP # TEST PIT HYDRANT LIGHT POLE □ CO.BD. COUNTY BOUND GPS POINT CABLE MANHOLE DRAINAGE MANHOLE ELECTRIC MANHOLE GAS MANHOLE MISC MANHOLE SEWER MANHOLE TELEPHONE MANHOLE WATER MANHOLE MASSACHUSETTS HIGHWAY BOUND MHB MHB MONUMENT □ MON □ SB STONE BOUND TB TOWN OR CITY BOUND TRAVERSE OR TRIANGULATION STATION → TPL or GUY → TPL or GUY TROLLEY POLE OR GUY POLE HTP TRANSMISSION POLE -&- UFB -6- UFB UTILITY POLE W/ FIREBOX -∳- UPDL → UPDL UTILITY POLE WITH DOUBLE LIGHT UTILITY POLE W / 1 LIGHT -6- ULT -⊱ ULT → UPL - UPL UTILITY POLE 0 BUSH •SIZE & TYPE TREE STUMP SWAMP / MARSH **WATER GATE** ₩G PARKING METER o PM PM LIGHT POLE WITH LUMINAIRE — — — OVERHEAD CABLE/WIRE CURBING =100 =99 = CONTOURS —— UNDERGROUND DRAIN PIPE (DOUBLE LINE 24 INCH AND OVER) - UNDERGROUND ELECTRIC DUCT (DOUBLE LINE 24 INCH AND OVER) — UNDERGROUND GAS MAIN (DOUBLE LINE 24 INCH AND OVER) ———— UNDERGROUND SEWER MAIN (DOUBLE LINE 24 INCH AND OVER) — UNDERGROUND TELEPHONE DUCT (DOUBLE LINE 24 INCH AND OVER) — UNDERGROUND WATER MAIN (DOUBLE LINE 24 INCH AND OVER) BALANCE STONE WALL GUARD RAIL - STEEL POSTS GUARD RAIL - WOOD POSTS ----- × ----- CHAIN LINK OR METAL FENCE ----- WOOD FENCE SEDIMENT CONTROL BARRIER TREE LINE OR LIMIT OF CLEARING AND GRUBBING — — — — SAWCUT LINE — — — — TOP OR BOTTOM OF SLOPE — — — LIMIT OF EDGE OF PAVEMENT OR COLD PLANE AND OVERLAY BANK OF RIVER OR STREAM BORDER OF WETLAND 100 FT WETLAND BUFFER 200 FT RIVERFRONT BUFFER — STATE HIGHWAY LAYOUT — TOWN OR CITY LAYOUT ——— COUNTY LAYOUT ------RAILROAD SIDELINE TOWN OR CITY BOUNDARY LINE PROPERTY LINE OR APPROXIMATE PROPERTY LINE — — — EASEMENT

TRAFFIC SYMBOLS

EXISTING	PROPOSED	DESCRIPTION
<i>0</i> 1	Ø 1	CONTROLLER PHASE ACTUATED
	000	TRAFFIC SIGNAL HEAD (SIZE AS NOTED)
		WIRE LOOP DETECTOR (6' x 6' TYP UNLESS OTHERWISE SPECIFIED)
	>== -	VIDEO DETECTION CAMERA
	>=	MICROWAVE DETECTOR
\oplus	•	PEDESTRIAN PUSH BUTTON, SIGN (DIRECTIONAL ARROW AS SHOWN) AND SADDLE
*	*	EMERGENCY PREEMPTION CONFIRMATION STROBE LIGHT
<	—	VEHICULAR SIGNAL HEAD
≪<	←	VEHICULAR SIGNAL HEAD, OPTICALLY PROGRAMMED
<	─	FLASHING BEACON
		PEDESTRIAN SIGNAL HEAD, (TYPE AS NOTED OR AS SPECIFIED)
⊠ RRSG	⊠ RRSG	RAILROAD SIGNAL
	•	SIGNAL POST AND BASE (ALPHA-NUMERIC DESIGNATION NOTED)
·—	€ 20'	MAST ARM, SHAFT AND BASE (ARM LENGTH AS NOTED)
		HIGH MAST POLE OR TOWER
	0	SIGN AND POST
00	00	SIGN AND POST (2 POSTS)
	★ ^{20'}	MAST ARM WITH LUMINAIRE
	=	OPTICAL PRE-EMPTION DETECTOR
	\bowtie	CONTROL CABINET, GROUND MOUNTED
	$ lap{\bullet}$	CONTROL CABINET, POLE MOUNTED
		FLASHING BEACON CONTROL AND METER PEDESTAL
	\bowtie	LOAD CENTER ASSEMBLY
		PULL BOX 12"x12" (OR AS NOTED)
		ELECTRIC HANDHOLE 12"x24" (OR AS NOTED)
		= TRAFFIC SIGNAL CONDUIT

GENERAL NOTES:

- THE LOCATIONS OF EXISTING UNDERGROUND UTILITIES ARE SHOWN IN AN APPROXIMATE WAY ONLY AND HAVE NOT BEEN INDEPENDENTLY VERIFIED BY THE OWNER OR ITS REPRESENTATIVE. THE CONTRACTOR SHALL DETERMINE THE EXACT LOCATION OF ALL EXISTING UTILITIES BEFORE COMMENCING WORK, AND AGREES TO BE FULLY RESPONSIBLE FOR ANY AND ALL DAMAGES WHICH MIGHT BE OCCASIONED BY THE CONTRACTOR'S FAILURE TO EXACTLY LOCATE AND PRESERVE ANY AND ALL UNDERGROUND UTILITIES.
- 2. THE CONTRACTOR SHALL CONTACT "DIG SAFE" AT 1-888-DIG-SAFE AT LEAST 72 HOURS PRIOR TO COMMENCING WORK ON THE PROJECT AREA. THE CONTRACTOR SHALL PROVIDE DIGSAFE REPORTING NUMBERS TO THE ENGINEER.
- 3. WHERE AN EXISTING UTILITY IS FOUND TO CONFLICT WITH THE PROPOSED WORK, THE LOCATION, ELEVATION AND SIZE OF THE UTILITY SHALL BE ACCURATELY DETERMINED WITHOUT DELAY BY THE CONTRACTOR, AND THE INFORMATION FURNISHED TO THE ENGINEER FOR RESOLUTION OF THE CONFLICT
- 4. THE CONTRACTOR SHALL MAKE ALL ARRANGEMENTS FOR THE ALTERATION AND ADJUSTMENT OF GAS, ELECTRIC, TELEPHONE AND ANY OTHER PRIVATE UTILITIES BY THE UTILITY COMPANIES AND WORK TO BE DONE BY OTHERS.
- 5. AREAS OUTSIDE THE LIMITS OF PROPOSED WORK DISTURBED BY THE CONTRACTOR'S OPERATIONS SHALL BE RESTORED BY THE CONTRACTOR TO THEIR ORIGINAL CONDITION AT THE CONTRACTOR'S EXPENSE
- 6. THE TERM "PROPOSED" (PROP.) MEANS WORK TO BE CONSTRUCTED USING NEW MATERIALS OR, WHERE APPLICABLE, REUSING EXISTING MATERIALS IDENTIFIED AS "REMOVE AND RESET" (R&R).
- 7. ALL EXISTING SIGNS WITHIN THE PROJECT LIMITS SHALL BE RETAINED UNLESS INDICATED OTHERWISE ON THE DRAWINGS.
- DRAINAGE ELEVATIONS ARE PROVIDED FOR DESIGN PURPOSES ONLY. THE CONTRACTOR SHALL VERIFY BY TEST PIT, THE LOCATIONS OF EXISTING UTILITIES WHICH MAY CONFLICT WITH THE PROPOSED DRAINAGE DESIGN. ANY FIELD ADJUSTMENTS REQUIRED WILL BE MADE AS APPROVED OR DIRECTED BY THE ENGINEER. ONLY AFTER THE CONTRACTOR VERIFIES ELEVATIONS FOR THE CONSTRUCTABILITY OF THE DRAINAGE SYSTEM SHALL ANY STRUCTURES BE ORDERED. ANY FIELD ADJUSTMENTS TO LINE & GRADE UP TO A DEPTH OF 5' SHALL BE INCLUDED IN THE COST OF THE PIPE. PIPE EXCAVATION GREATER THAN 5' WILL BE PAID UNDER CLASS B TRENCH EXCAVATION.
- 9. FIELD SURVEY PROVIDED BY CHAPPELL ENGINEERING ASSOCIATES, 201 BOSTON POST ROAD, MARLBOROUGH, MA 01752 IN NOVEMBER 2020. HORIZONTAL DATUM IS BASED ON MASS GRID SYSTEM NAD 1983. ELEVATIONS SHOWN ON THE PLAN REFER TO THE NAVD OF 1988.

ADDDE\/IATIONS ADDDENIATIONS (cont.)

ABBREV	IATIONS	ABBREV	/IATIONS (cont.)
GENERAL		GENERAL	,
AADT	ANNUAL AVERAGE DAILY TRAFFIC	MAX	MAXIMUM
ABAN	ABANDON	MB	MAILBOX
ADJ	ADJUST	MH	MANHOLE
APPROX.	APPROXIMATE	MHB	MASSACHUSETTS HIGHWAY BOUND
A.C.	ASPHALT CONCRETE	MIN	MINIMUM
ACCM PIPE	ASPHALT COATED CORRUGATED METAL PIPE	NIC	NOT IN CONTRACT
BIT.	BITUMINOUS	NO.	NUMBER
BC	BOTTOM OF CURB	PC	POINT OF CURVATURE
BD.	BOUND	PCC	POINT OF COMPOUND CURVATURE
BL	BASELINE	P.G.L.	PROFILE GRADE LINE
BLDG	BUILDING	P.G.L.	POINT OF INTERSECTION
BLDG	BENCHMARK	POC	POINT OF INTERSECTION POINT ON CURVE
BO	BY OTHERS	POT	POINT ON CORVE POINT ON TANGENT
		_	
BOS	BOTTOM OF SLOPE	PRC	POINT OF REVERSE CURVATURE
BR.	BRIDGE	PROJ	PROJECT
CB	CATCH BASIN	PROP	PROPOSED
CBCI	CATCH BASIN WITH CURB INLET	PSB	PLANTABLE SOIL BORROW
CC	CEMENT CONCRETE	PT	POINT OF TANGENCY
CCM	CEMENT CONCRETE MASONRY	PVC	POINT OF VERTICAL CURVATURE
CEM	CEMENT	PVI	POINT OF VERTICAL INTERSECTION
CI	CURB INLET	PVT	POINT OF VERTICAL TANGENCY
CIP	CAST IRON PIPE	PVMT	PAVEMENT
CLF	CHAIN LINK FENCE	PWW	PAVED WATER WAY
CL	CENTERLINE	R	RADIUS OF CURVATURE
CMP	CORRUGATED METAL PIPE	R&D	REMOVE AND DISPOSE
CRETW	CONCRETE RETAINING WALL	RCP	REINFORCED CONCRETE PIPE
CSP	CORRUGATED STEEL PIPE	RD	ROAD
CO.	COUNTY	RDWY	ROADWAY
CONC	CONCRETE	REM	REMOVE
CONT	CONTINUOUS	RET	RETAIN
CONST	CONSTRUCTION	RET WALL	RETAINING WALL
CR GR	CROWN GRADE	ROW	RIGHT OF WAY
DHV	DESIGN HOURLY VOLUME	RR	RAILROAD
DI	DROP INLET	RRFB	RECTANGULAR RAPID FLASH BEACON
DIA	DIAMETER	R&R	REMOVE AND RESET
DIP	DUCTILE IRON PIPE	R&S	REMOVE AND STACK
DW	STEADY DON'T WALK - PORTLAND ORANGE	RT	RIGHT
DWY	DRIVEWAY	SB	STONE BOUND
ELEV (or EL.)		SHLD	SHOULDER
EMB	EMBANKMENT	SMH	SEWER MANHOLE
EOP	EDGE OF PAVEMENT	ST	STREET
EXIST (or EX)		STA	STATION
EXC	EXCAVATION	SSD	STOPPING SIGHT DISTANCE
	FRAME AND COVER	SHLO	STATE HIGHWAY LAYOUT LINE
F&C		SW	SIDEWALK
F&G	FRAME AND GRATE	T	TANGENT DISTANCE OF CURVE/TRUCK
FDN.	FOUNDATION	TAN	TANGENT
FLDSTN	FIELDSTONE	TEMP	TEMPORARY
GAR	GARAGE	TC	TOP OF CURB
GD	GROUND	TOS	TOP OF CORB
GG	GAS GATE		
GI	GUTTER INLET	TYP	TYPICAL
GIP	GALVANIZED IRON PIPE	UP	UTILITY POLE
GRAN	GRANITE	VAR	VARIES
GRAV	GRAVEL	VERT	VERTICAL OUR / F
GRD	GUARD	VC	VERTICAL CURVE
HDW	HEADWALL	WCR	WHEEL CHAIR RAMP
HMA	HOT MIX ASPHALT	WG	WATER GATE
HOR	HORIZONTAL	WIP	WROUGHT IRON PIPE
HYD	HYDRANT	WM	WATER METER/WATER MAIN
INV	INVERT	X-SECT	CROSS SECTION
JCT	JUNCTION		
1	LENGTH OF CURVE		
L	LEACH BACIN		

CLIENT:

TOWN OF LUNENBURG

17 MAIN STREET LUNENBURG, MA 01642 PHONE: 978-582-4144

COMPLETE STREETS PROJECT THREE LOCATIONS LUNENBURG, MA

PROJECT:



300 TRADECENTER, SUITE 5580 **WOBURN, MA 01801** T: 781-933-4800 F: 781-933-4801

	NO.	DATE	REVISION	SCALE:	NONE	
				DATE:	MARCH 2021	
				WTE PROJ. NO:	20-019.01	
				DESIGNED BY:	КМС	
PROFESSIONAL CIVIL ENGINEER FOR WORLDTECH ENGINEERING, LLC				CHECKED BY:	TFQ	

LEACH BASIN

LIGHT POLE


LOW POINT

LEFT


LP


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DRAWING TITLE: SHEET NO. LEGEND, ABBREVIATIONS & GENERAL NOTES



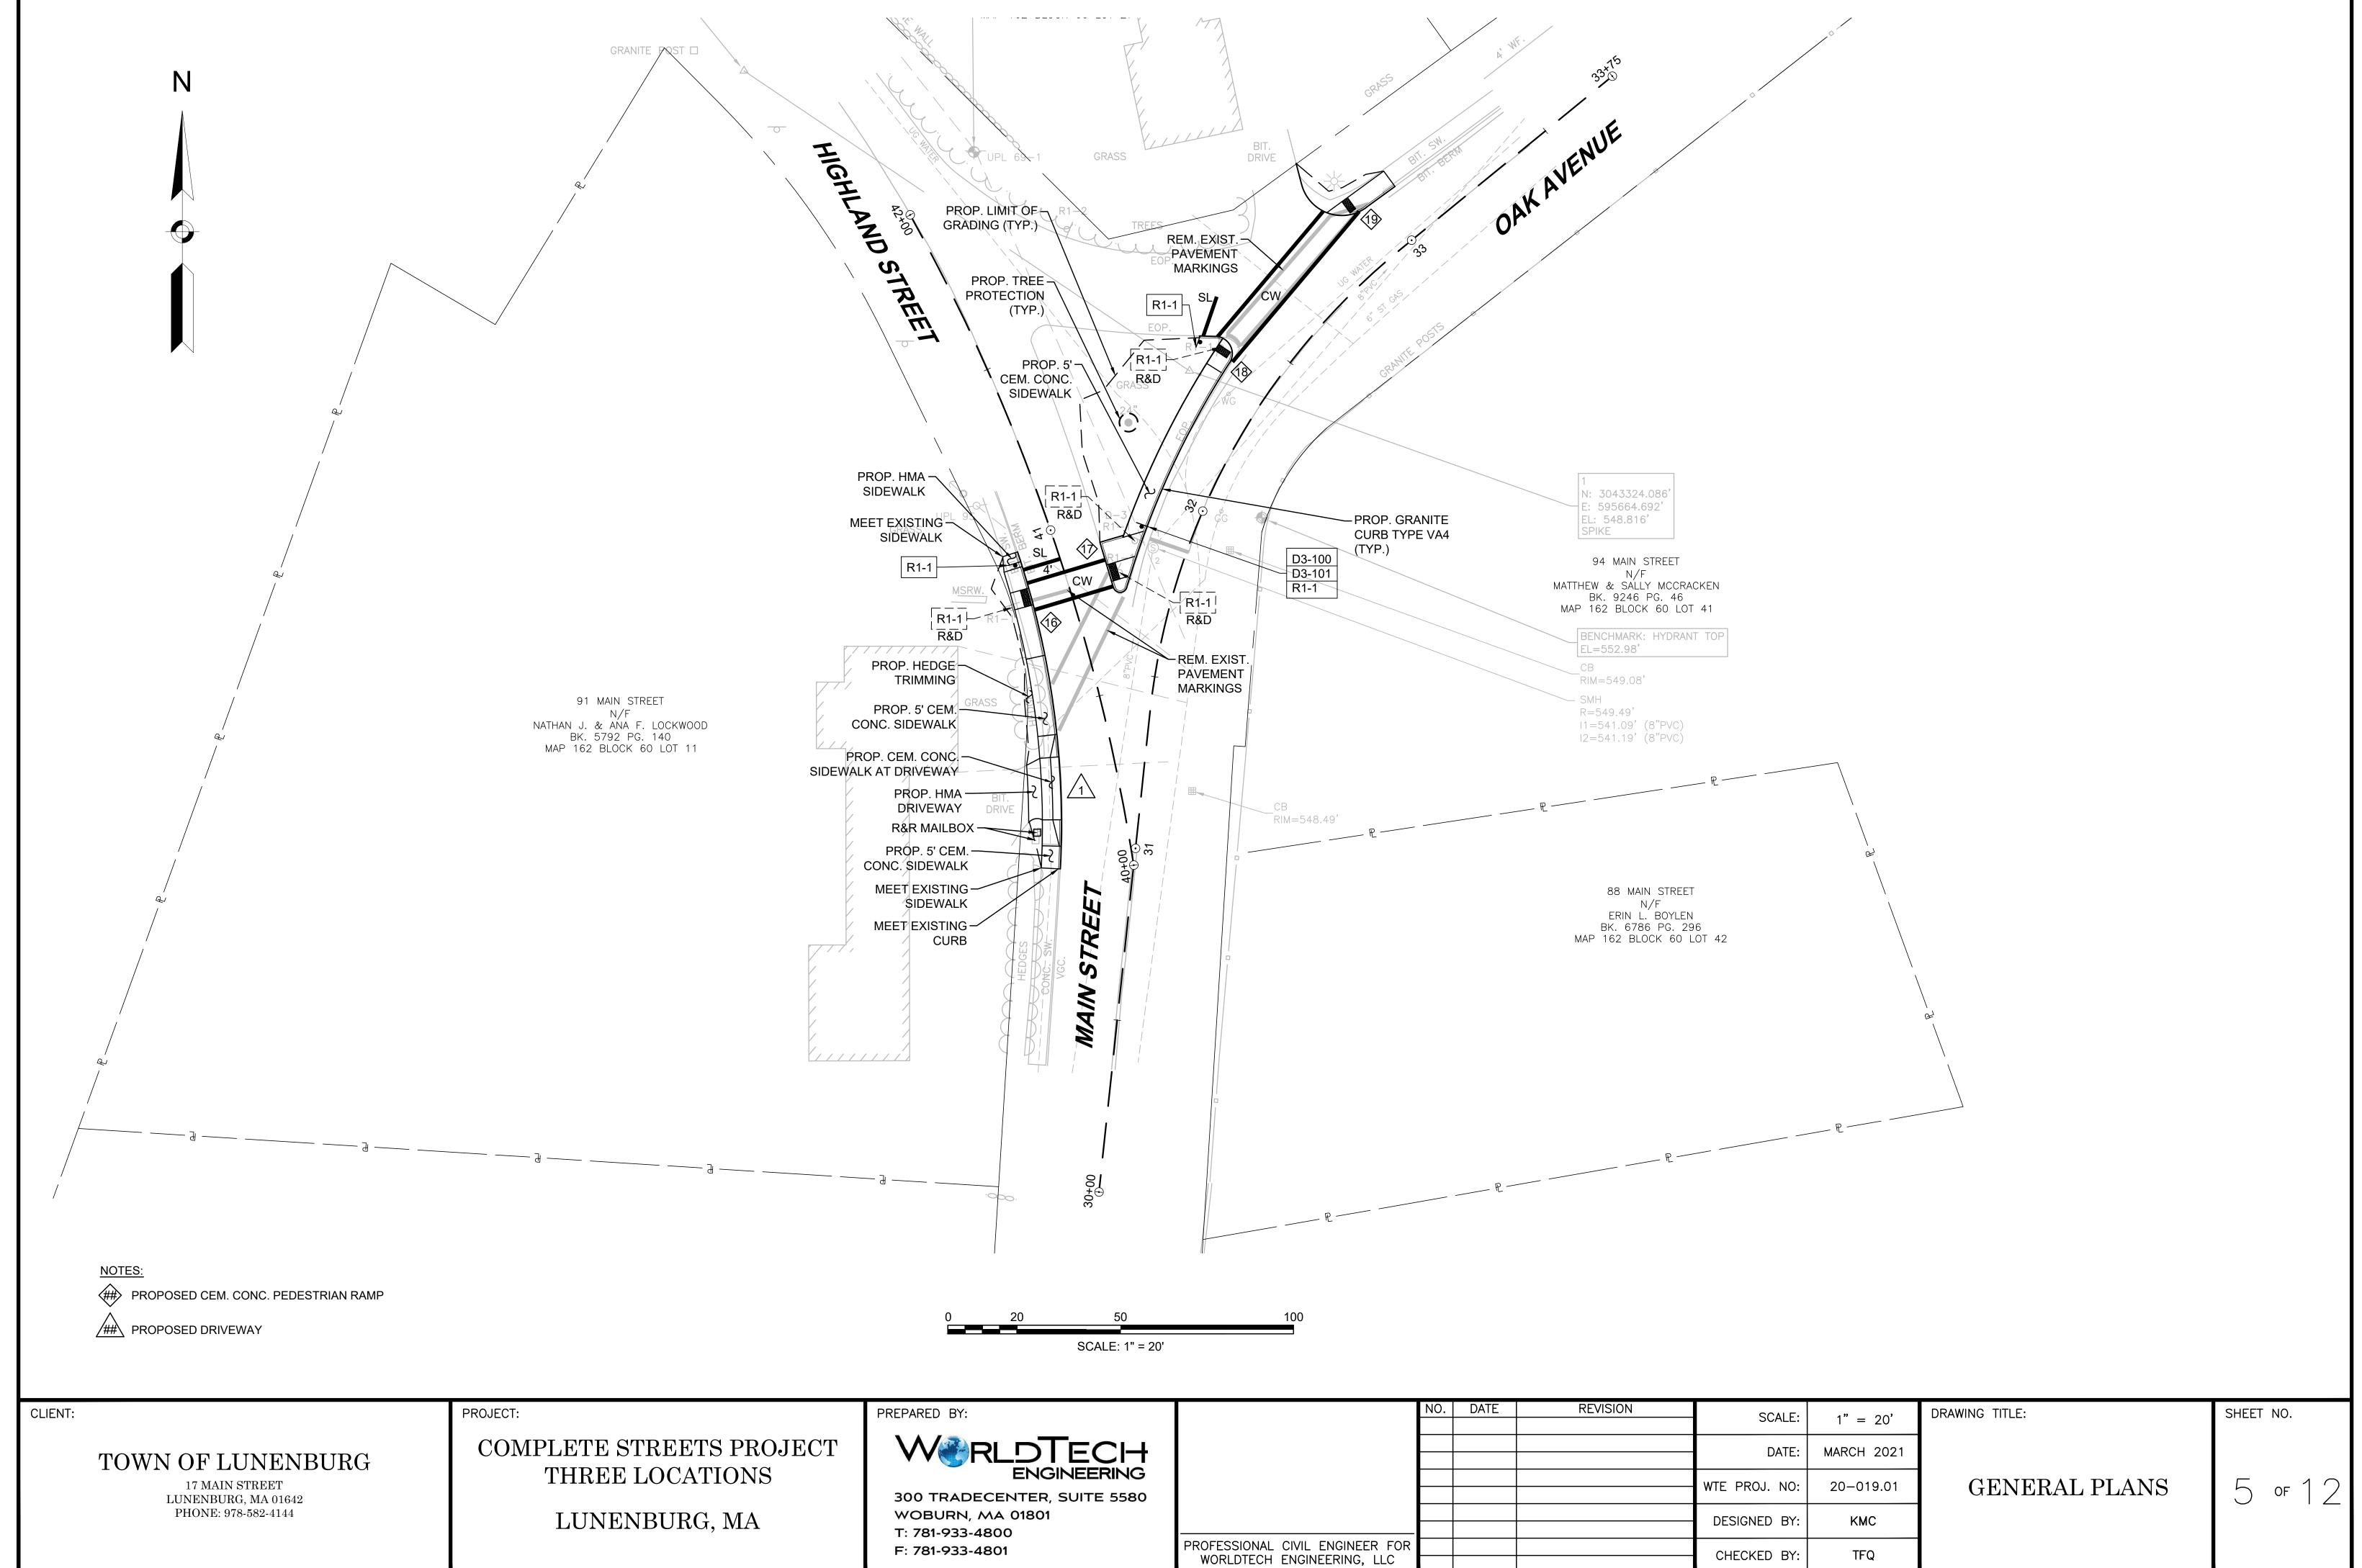



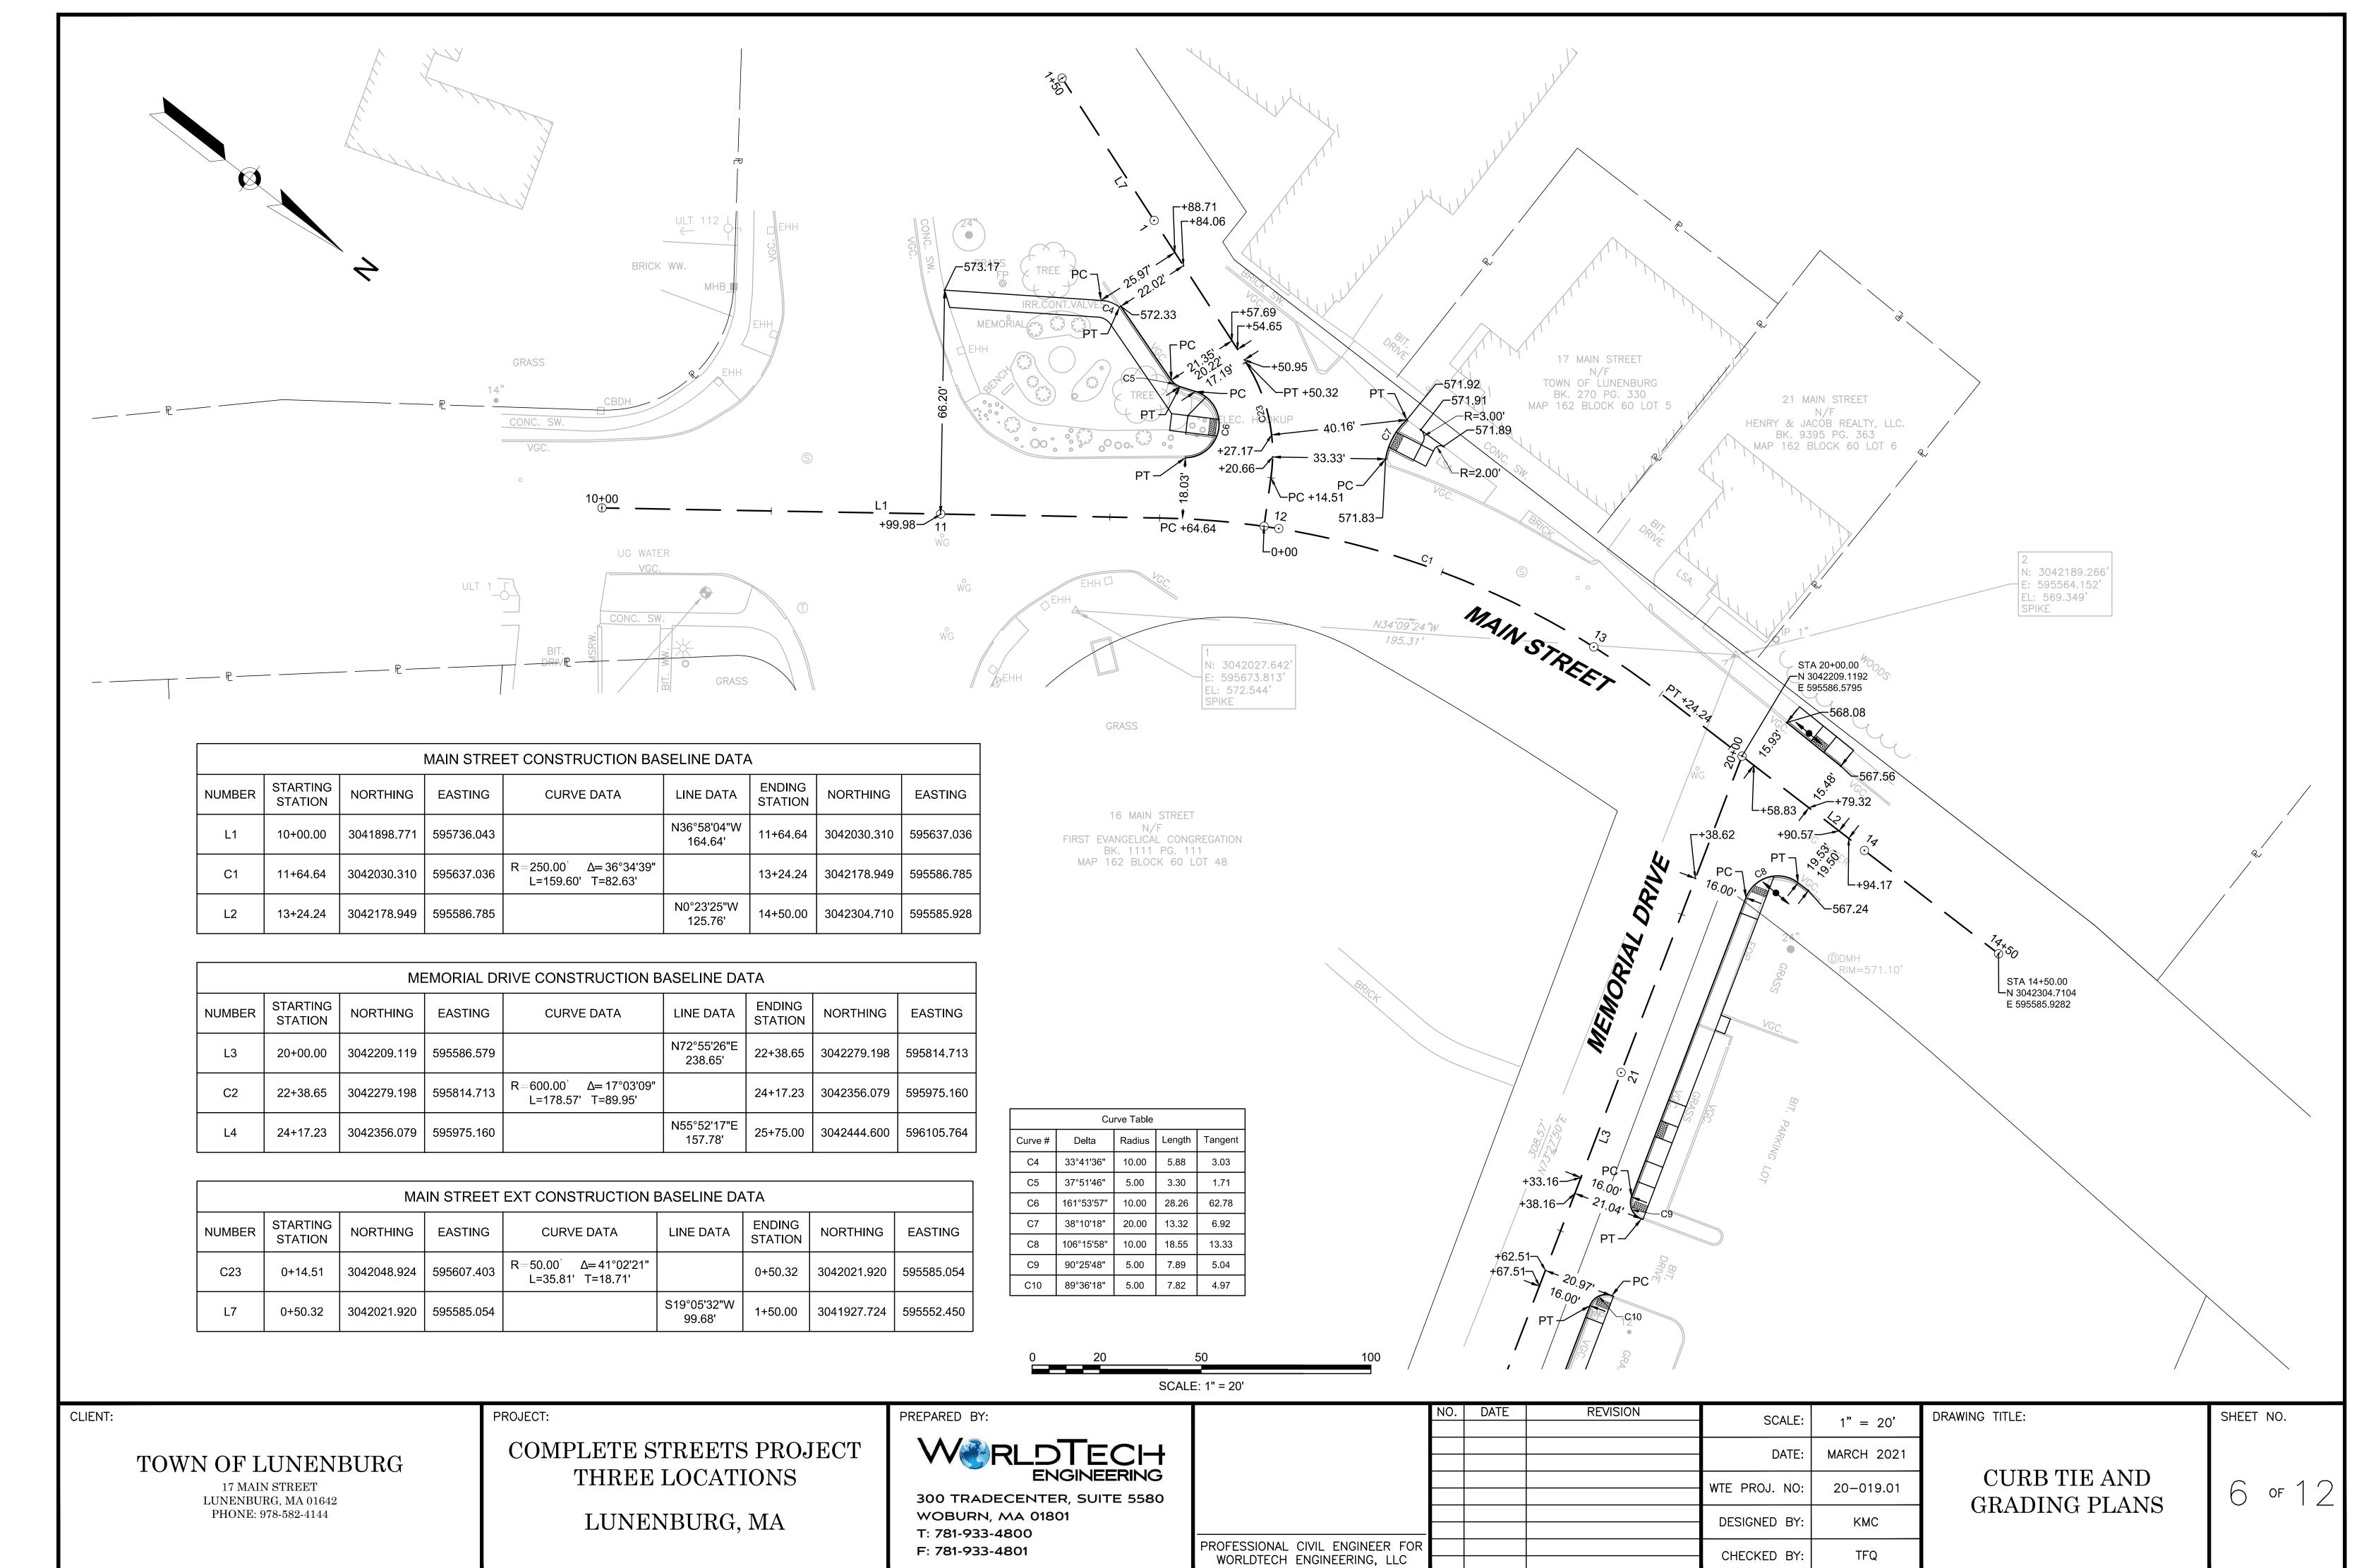


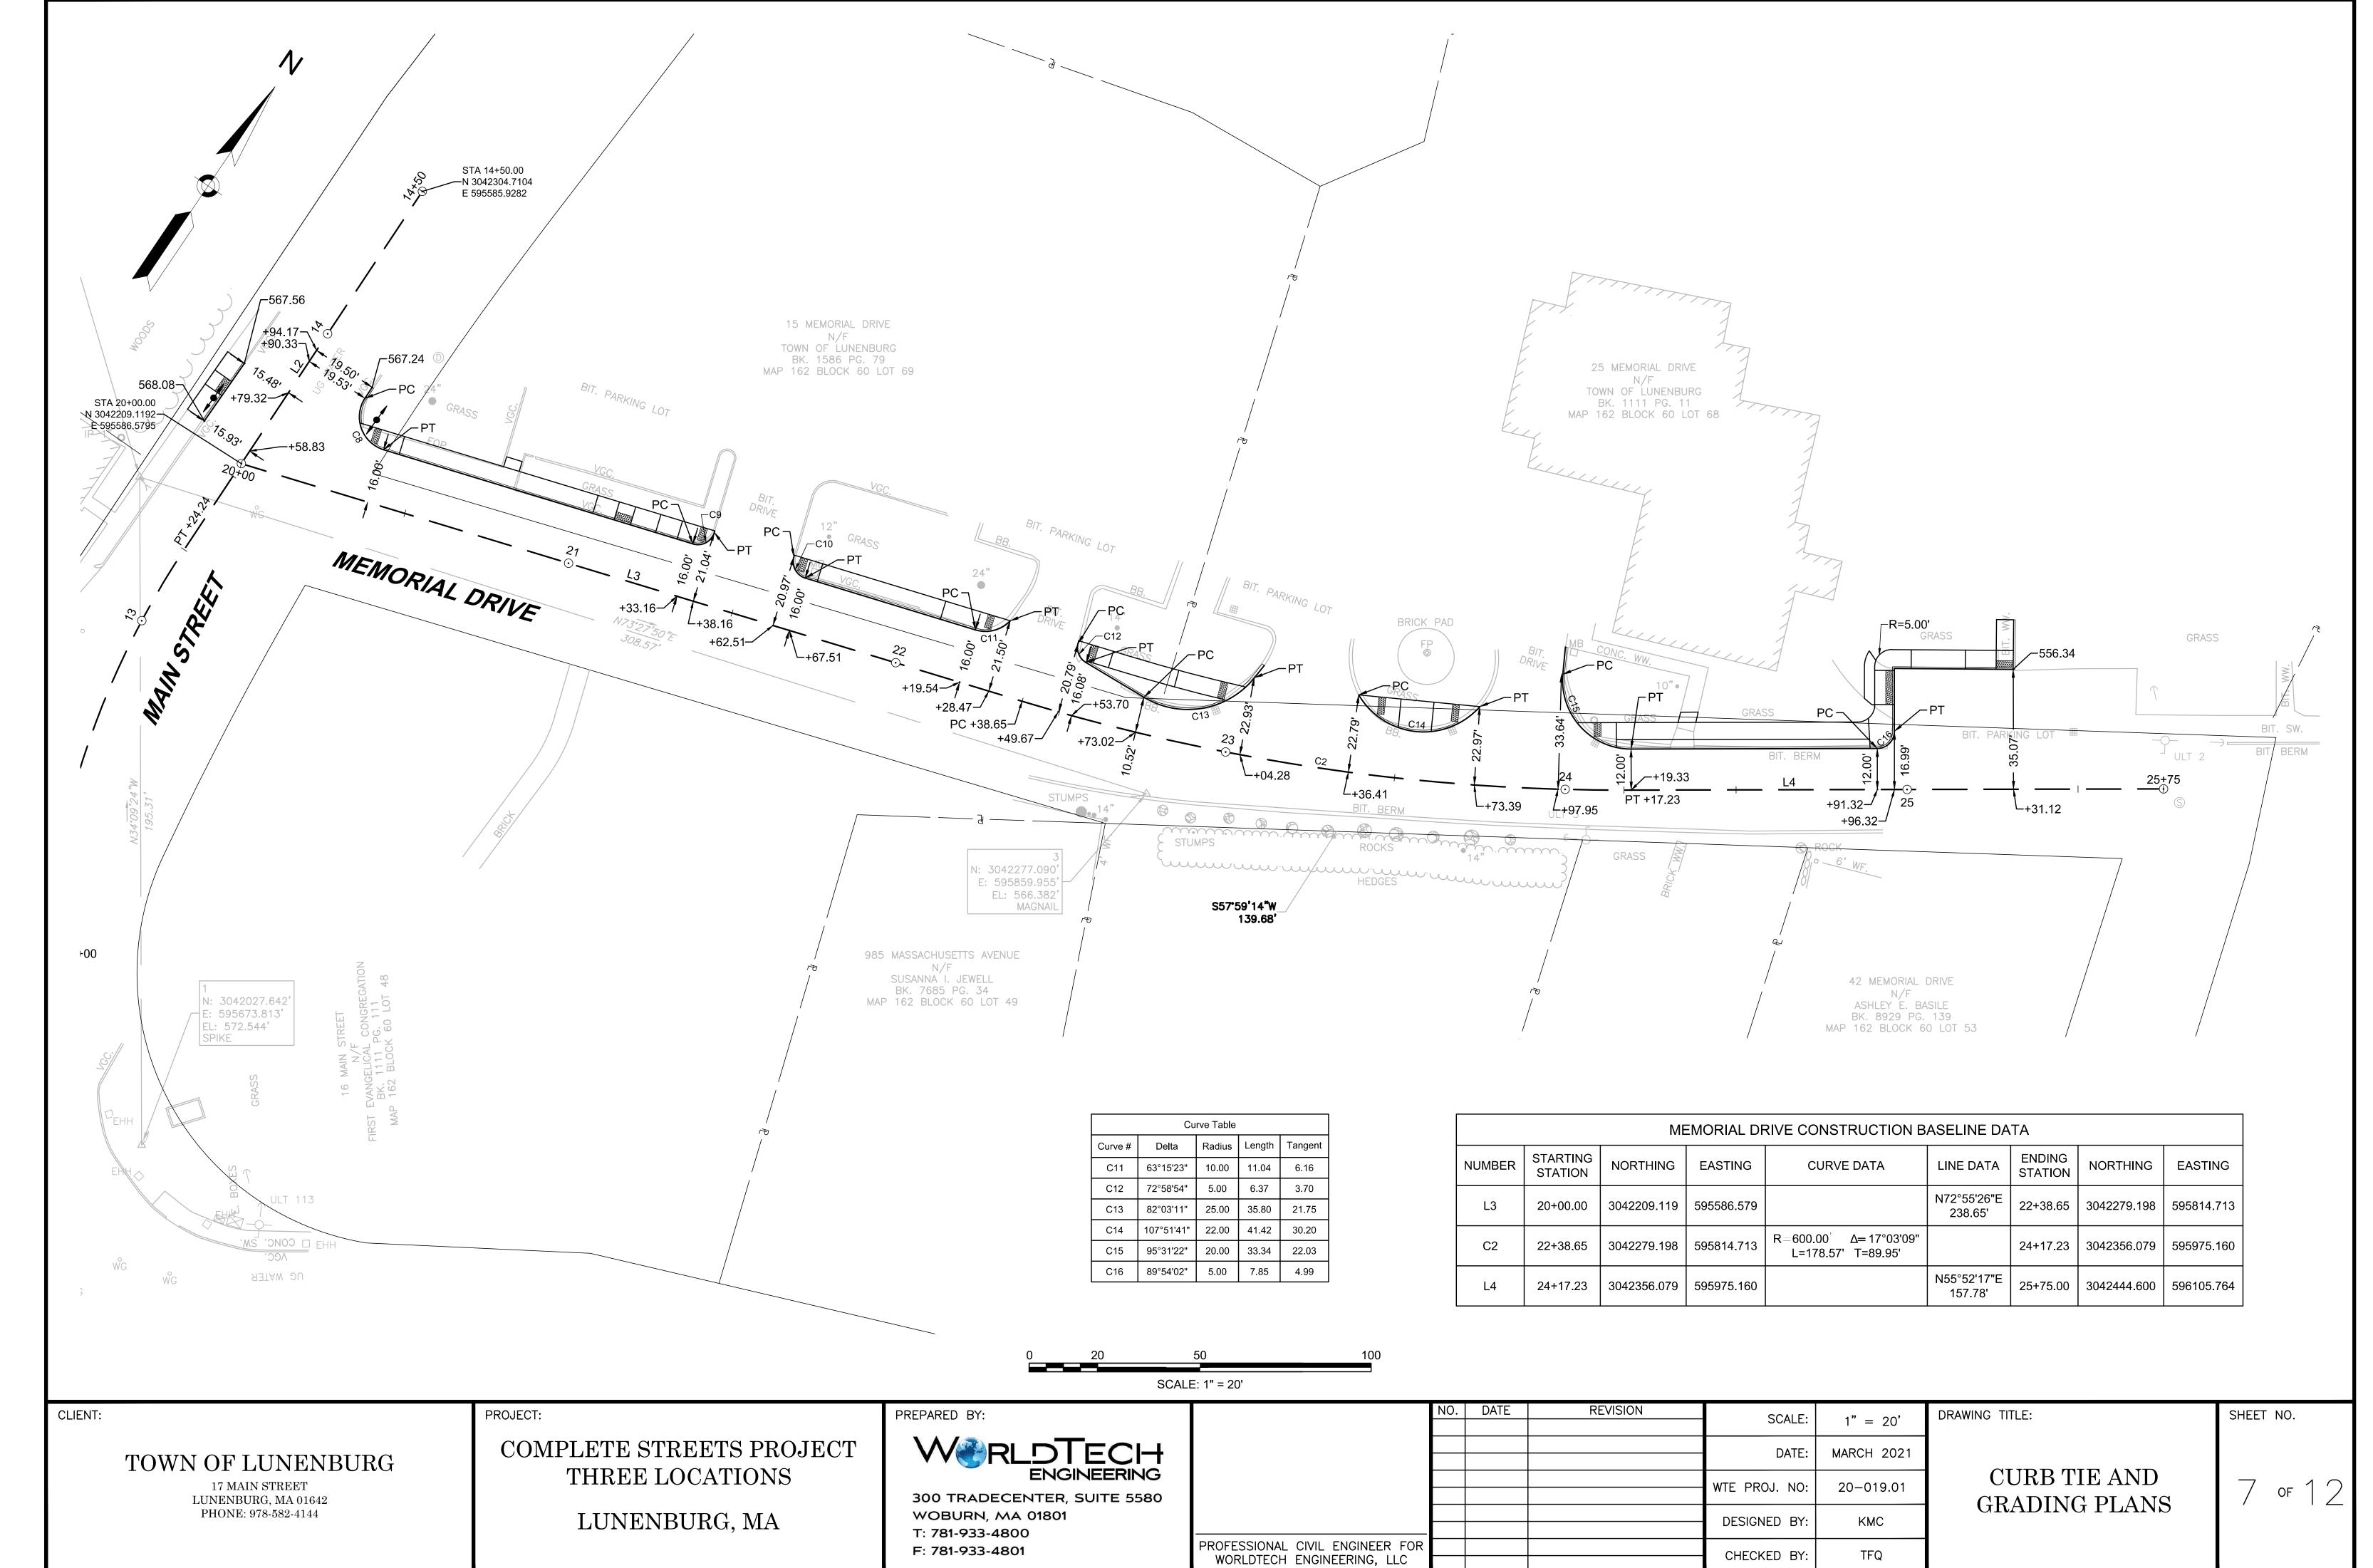CHECKED BY:

TFQ

F: 781-933-4801

GRANITE POST [

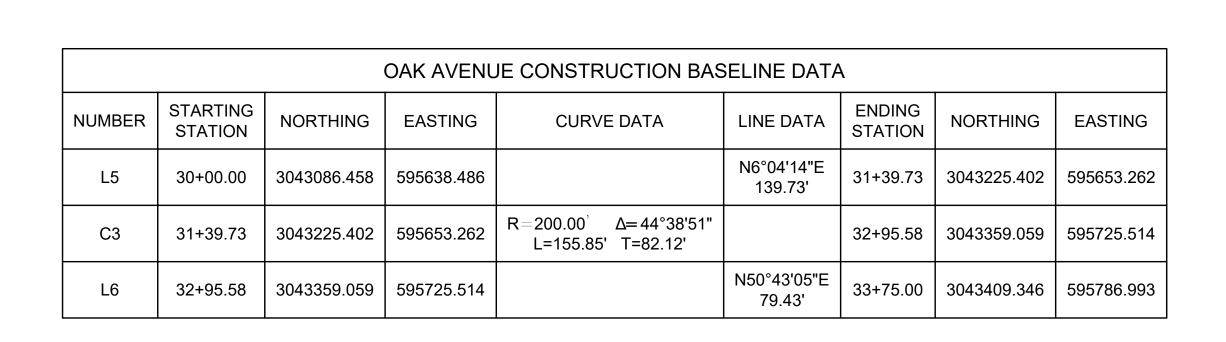

STA 33+75.00 N 3043409.3465 E 595786.9931

N: 3043324.086' E: 595664.692 EL: 548.816'

94 MAIN STREET

MATTHEW & SALLY MCCRACKEN BK. 9246 PG. 46 MAP 162 BLOCK 60 LOT 41

BENCHMARK: HYDRANT TOP

SPIKE

EL=552.98'

+87.01 PT +95.58

	HIGHLAND STREET CONSTRUCTION BASELINE DATA									
NUMI	NUMBER STARTING STATION NORTHING EASTING				CURVE DATA	LINE DATA	ENDING STATION	NORTHING	EASTING	
C2	22	40+00.00	3043181.035	595648.544	R=569.05 [°] Δ=20°08'14" L=200.00' T=101.04'		42+00.00	3043369.204	595583.871	

300 TRADECENTER, SUITE 5580

	NO.	DATE	REVISION	SCALE:	1" = 20'	DRAWING TITLE:
				DATE:	MARCH 2021	
				WTE PROJ. NO:	20-019.01	CDAD
				DESIGNED BY:	KMC	GRAD:
PROFESSIONAL CIVIL ENGINEER FOR WORLDTECH ENGINEERING, LLC				CHECKED BY:	TFQ	

CURB TIE AND GRADING PLANS

8 of 12

SHEET NO.

TRAFFIC SIGN SUMMARY

				T			T					I	T
SIGN ID	S	IZE	MESSAGE	DI	MENSIONS (IN)	NUMBER		COLOR	I	POST SIZE AND	UNIT AREA	TOTAL AREA
NUMBER	WIDTH (IN)	IDTH HEIGHT		LETTER HEIGHT	VERTICAL SPACING	ARROW RTE. MKR.	REQUIRED	BACK- GROUND	LEGEND	BORDER	NUMBER REQUIRED	(S.F.)	(S.F.)
D3-100	51	12	Highland St	6D / 4D 4.5D / 3.375D	3" 3"	N/A	2	GREEN	WHITE	WHITE	MOUNT WITH R1-1	EACH	EACH
D3-101	39	12	Oak Ave	6D / 4D 4.5D / 3.375D	3" 3"	N/A	2	GREEN	WHITE	WHITE	MOUNT WITH R1-1	EACH	EACH
R1-1	30	30	STOP	1	1	1	6	RED	WHITE	WHITE	P5 6 REQ'D	6.25	37.50
R7-1	12	18	NO PARKING ANY TIME				2	WHITE	RED	RED	P5 2 REQ'D	1.50	3.00
R7-5	12	18	ONE HOUR PARKING				1	WHITE	GREEN	GREEN	P5 1 REQ'D	1.50	1.50
R10-25	9	12	PUSH BUTTON TO TURN ON WARMING LIGHTS				2	WHITE	BLACK	BLACK	MOUNT WITH RRFB'S	0.75	1.50
W11-2	30	30					4	FLOR. YELLOW GREEN	BLACK	BLACK	MOUNT WITH RRFB'S	6.25	25.00
W16-7p	24	12			Y		4	FLOR. YELLOW GREEN	BLACK	BLACK	MOUNT WITH RRFB'S	2.00	8.00
											TOTAL AR	EA	76.50

TEMPORARY CONSTRUCTION SIGN SUMMARY

SIGN ID	SI	IZE		DI	MENSIONS (IN)	- NUMBER		COLOR	
NUMBER	WIDTH (IN)	HEIGHT (IN)	MESSAGE	LETTER HEIGHT	VERTICAL SPACING	ARROW RTE. MKR.	REQUIRED	BACK- GROUND	LEGEND	BORDER
MA-R2-10a	30	24	WORK ZONE SPEEDING FINES DOUBLED	2	2	2	4	ORANAGE WHITE	BLACK	BLACK
MA-R2-10e	24	30	END ROAD WORK DOUBLE FINES END	*	Y	Y	4	ORANAGE WHITE	BLACK	BLACK
R9-9	36	18	SIDEWALK CLOSED	1	1	1	2	ORANGE	BLACK	BLACK
W13-1	24	24	XX MPH				2	ORANAGE	BLACK	BLACK
W20-1	36	36	ROAD WORK AHEAD	*	Y	¥	4	ORANAGE	BLACK	BLACK
MA-W20-7b	36	36	POLICE OFFICER AHEAD	2	2	2	3	ORANAGE	BLACK	BLACK

SIGN SUMMARY NOTES:

- NUMERICAL LIMITS AND JUSTIFCATION FOR SPEED &
 ADVISORY EXIT SPEED SIGNS SHALL BE OBTAINED FROM
 THE SPEED ZONING UNIT OF THE TRAFFIC ENGINEERING
 SECTION, MASSDOT, BEFORE FABRICATION AND/OR
 ERECTION.
- 2. HIGH INTENSITY ENCAPSULATED LENS REFLECTIVE SHEETING SHALL BE USED FOR ALL SIGNS. THE "MANUAL ON UNIFORM TRAFFIC CONTROL DEVICES" 2009 EDITION, THE 1996 MASSDOT CONSTRUCTION AND TRAFFIC STANDARD DETAILS", AND ALL ADMENDMENTS WILL GOVERN.
- 3. ① SEE MUTCD 2009 EDITION, 1979 STD. HWY. SIGNS AND SECTION M9.30.0 TYPE III OF THE MASSDOT STANDARD SPECIFICATION FOR TEXT DIMENSIONS AND COLOR.
- ② SEE MASSDOT SIGN STANDARDS.

CLIENT:

TOWN OF LUNENBURG

17 MAIN STREET LUNENBURG, MA 01642 PHONE: 978-582-4144 COMPLETE STREETS PROJECT
THREE LOCATIONS
LUNENBURG, MA

PROJECT:

PREPARED BY:

WORLDTECH
ENGINEERING

300 TRADECENTER, SUITE 5580 WOBURN, MA 01801 T: 781-933-4800

F: 781-933-4801

	NO.	DATE	REVISION			
	110.	DATE	KEVISION	SCALE:	NONE	DRAWING TITLE:
				DATE:	MARCH 2021	/UD A T
				WTE PROJ. NO:	20-019.01	TRAF
				DESIGNED BY:	KMC	SU
PROFESSIONAL CIVIL ENGINEER FOR WORLDTECH ENGINEERING, LLC				CHECKED BY:	TFQ	

TRAFFIC SIGN
SUMMARY

SHEET NO.

) of 12

PAVEMENT NOTES:

PROPOSED CEMENT CONCRETE SIDEWALKS / WALKS / WHEELCHAIR RAMP:

4" CEMENT CONCRETE

AIR ENTRAINED 4000 PSI, 3/4" 610 OVER 8" GRAVEL BORROW

PROPOSED CEMENT CONCRETE SIDEWALK AT DRIVEWAY:

6" CEMENT CONCRETE AIR ENTRAINED 4000 PSI, 3/4" 610 OVER

8" GRAVEL BORROW

PROPOSED HMA WALK:

1 1/4" SUPERPAVE SURFACE COURSE - 9.5 (SSC-9.5) OVER 1 3/4" SUPERPAVE SURFACE COURSE - 12.5 (SSC-12.5) OVER 8" GRAVEL BORROW

PROPOSED HMA DRIVEWAYS:


1 1/2" SUPERPAVE SURFACE COURSE - 9.5 (SSC-9.5) OVER 2 1/2" SUPERPAVE SURFACE COURSE - 12.5 (SSC-12.5) OVER 8" GRAVEL BORROW

PROPOSED BARK MULCH: 4" AGED PINE BARK MULCH

PROPOSED LAWNS AND SLOPES: 4" LOAM AND SEED


GENERAL NOTES:

1. PREPARATION OF UNDERLYING SURFACE, ASPHALT EMULSION FOR TACK COAT, HMA FOR PATCHING AND HMA JOINT SEALANT SHALL BE IN ACCORDANCE WITH SECTION 450.

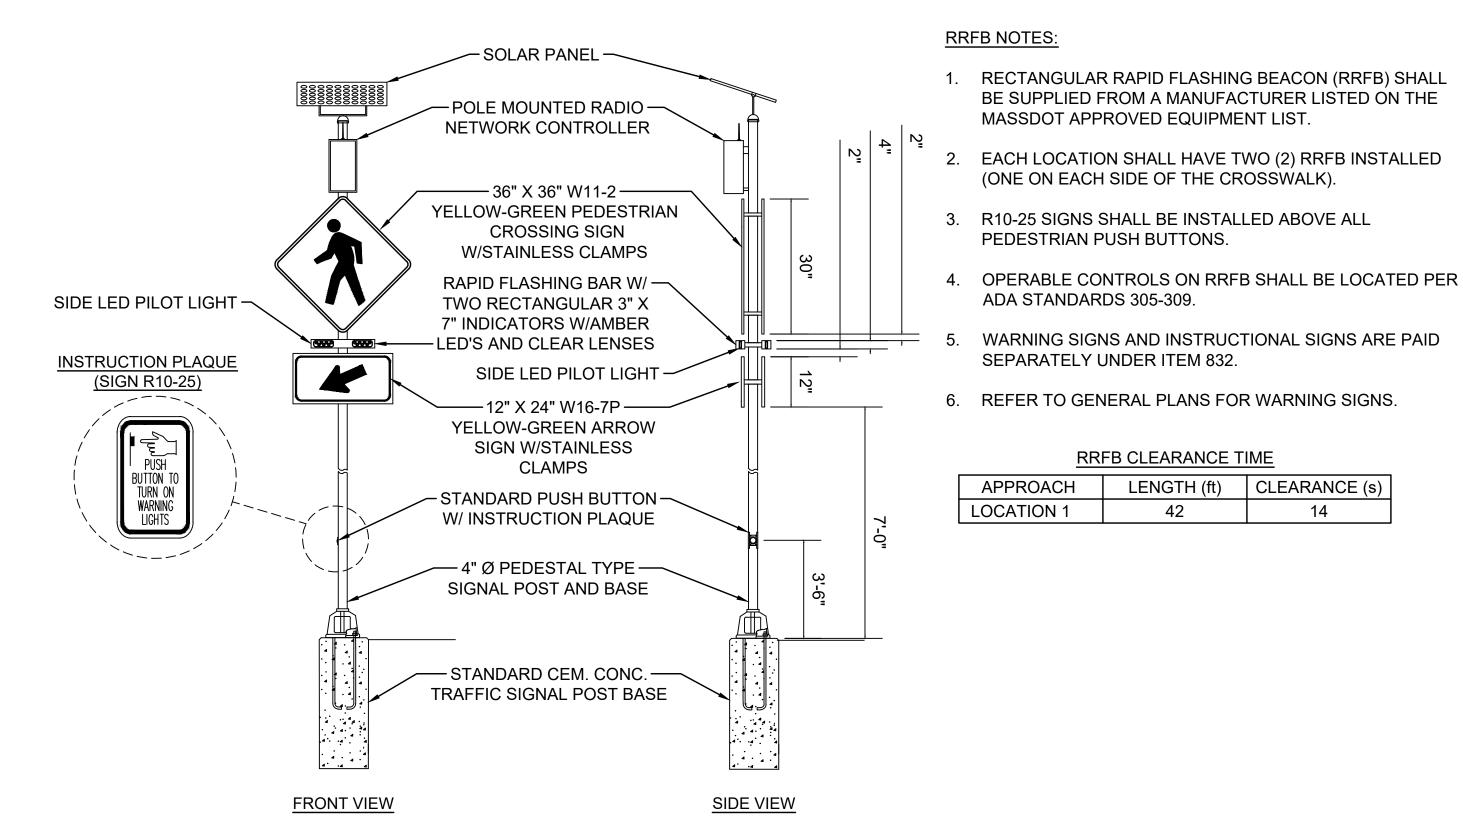

RECTANGULAR RAPID FLASHING BEACON (SOLAR)

N.T.S.

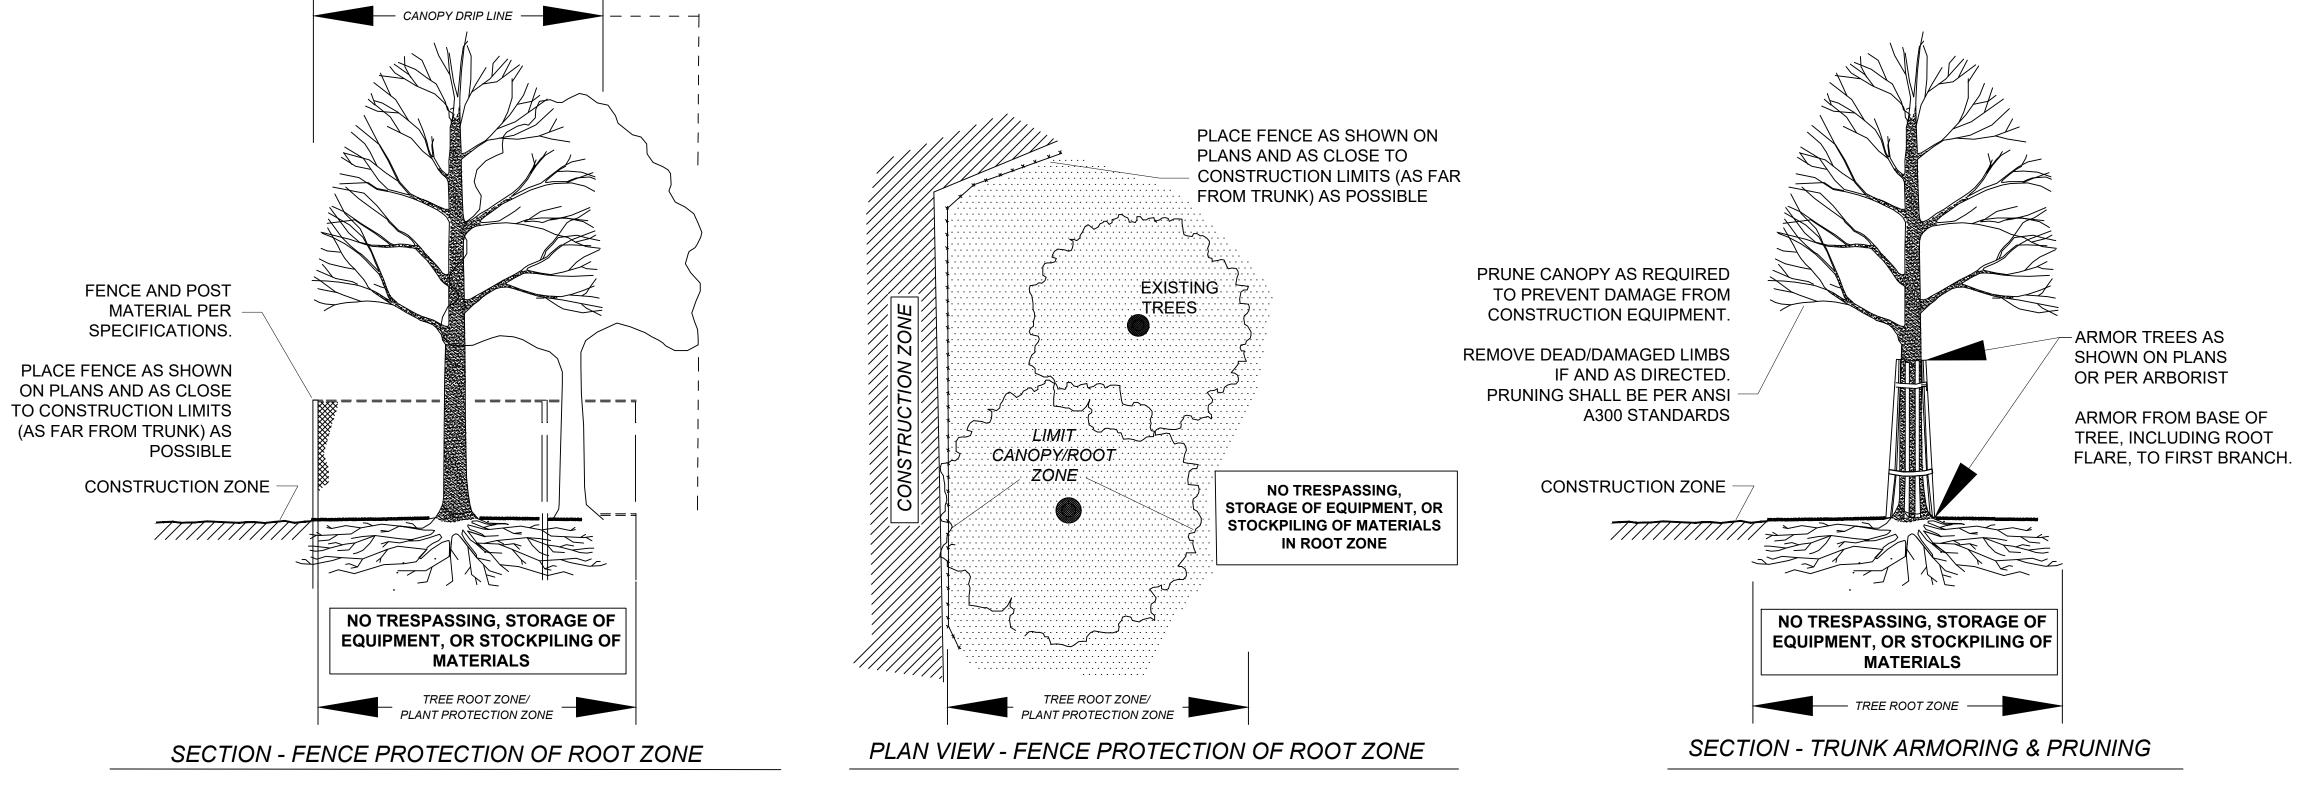

TREE PROTECTION DETAIL N.T.S.

CLIENT:

TOWN OF LUNENBURG

17 MAIN STREET LUNENBURG, MA 01642 PHONE: 978-582-4144

PROJECT: COMPLETE STREETS PROJECT THREE LOCATIONS

LUNENBURG, MA

PREPARED BY:

F: 781-933-4801


300 TRADECENTER, SUITE 5580 **WOBURN, MA 01801** T: 781-933-4800

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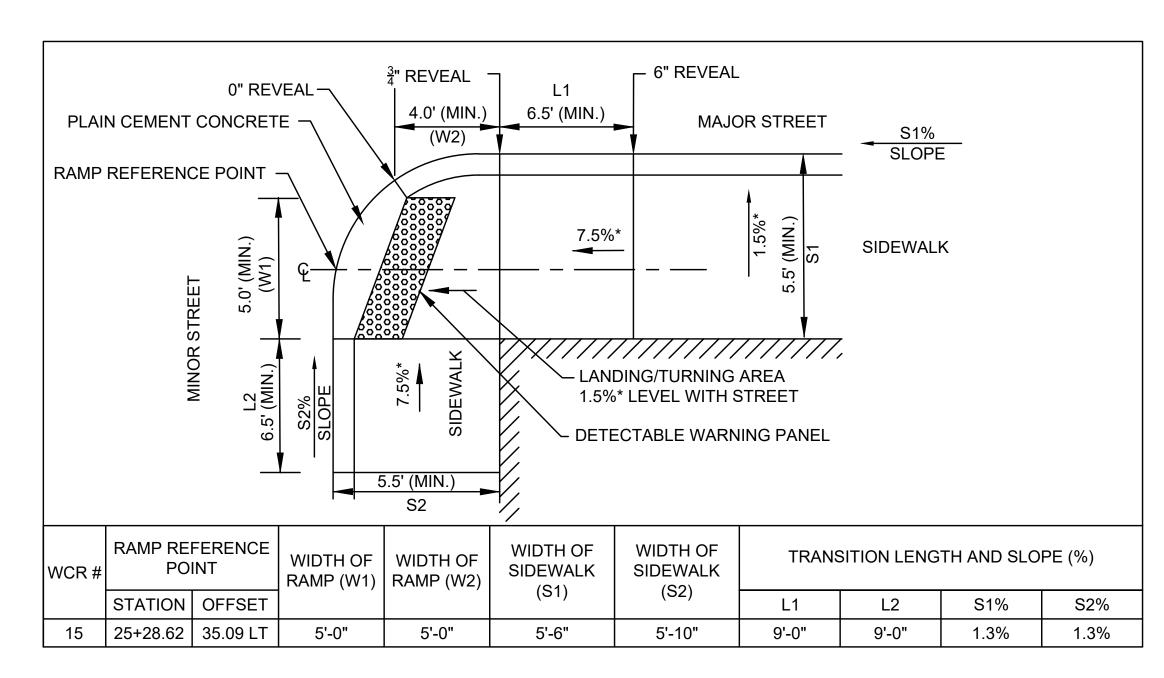
DRAWING TITLE: CONSTRUCTION DETAILS AND PAVEMENT NOTES

10 of 12

SHEET NO.

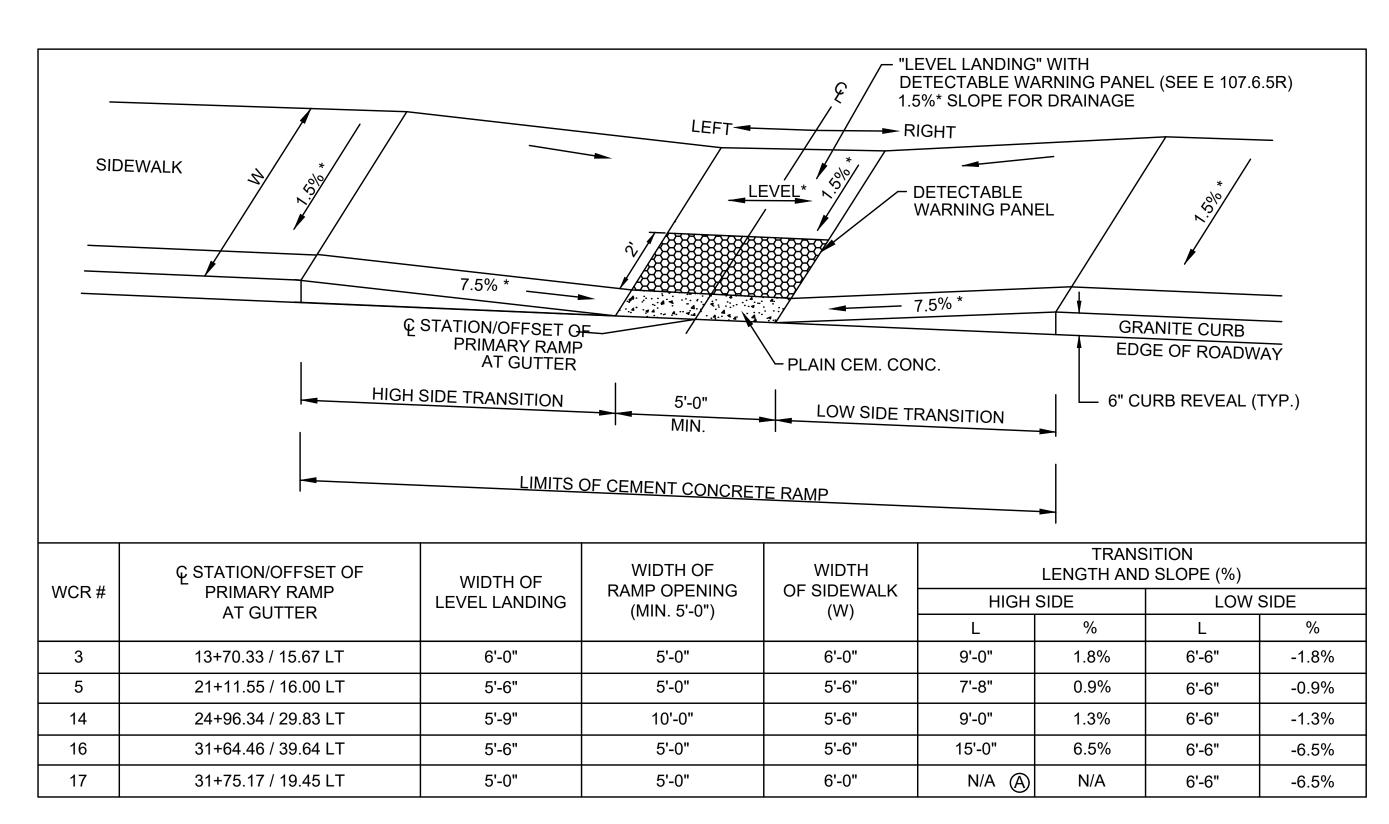

PEDESTRIAN CURB RAMP ON NARROW SIDEWALK (DEPTH LESS THAN 6'-6")



"T" INTERSECTION PEDESTRIAN CURB RAMP


NOTES:

* CONSTRUCTION TOLERANCE ±0.5%.

(A) NO TRANSITION, 6" CURB REVEAL


DETECTABLE WARNING PANELS SHALL BE INCLUDED ON ALL PROPOSED PEDESTRIAN CURB RAMPS AS SHOWN IN THE MASSDOT CONSTRUCTION STANDARDS ISSUED IN OCTOBER 2017, DRAWING NO. E 107.6.5.

B 3" CURB REVEAL

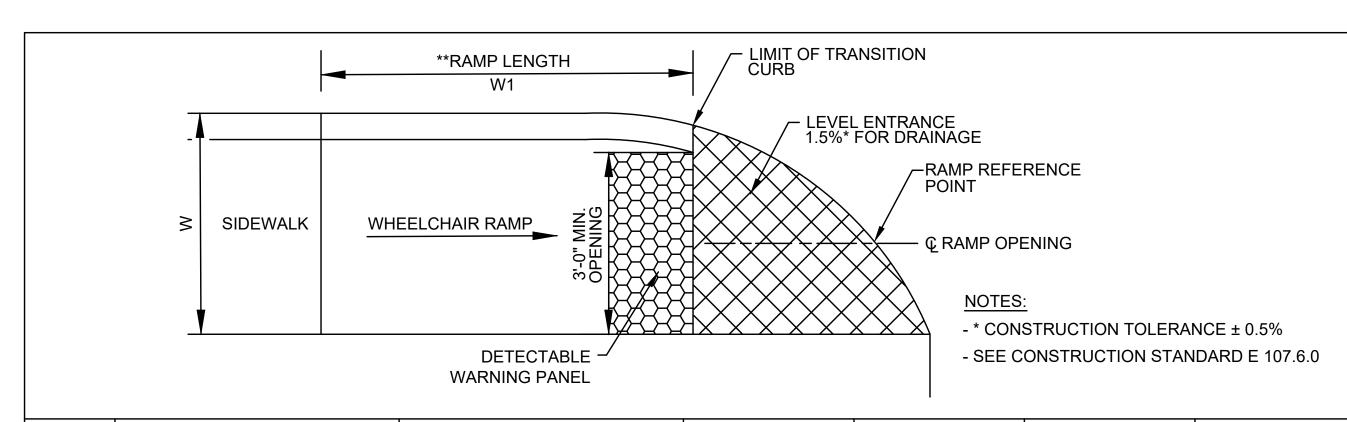

WCR#	RAMP REFER	RENCE POINT	LIMIT OF TRAN	ISITION CURVE	WIDTH OF SIDEWALK	WIDTH OF RAMP OPENING	ROADWAY GUTTER	LENGTH OF RAMP	
	STATION OFFSET S		STATION	OFFSET	(W)	(MIN. 3'-0")	SLOPE	(W1)	
4	13+82.17	23.84 RT	13+80.55	27.82 RT	5'-6"	5'-6"	1.8%	9'-0"	
6	21+37.93	19.50 LT	21+36.31	17.11 LT	5'-6"	4'-0"	0.9%	7'-8"	
7	21+62.74	19.50 LT	21+64.37	17.11 LT	5'-6"	4'-0"	-0.9%	6'-6"	
8	22+27.12	19.47 LT	22+24.01	17.05 LT	5'-6"	4'-0"	4.4%	15'-0"	
9	22+50.11	19.18 LT	22+53.70	16.08 LT	5'-0"	5'-0"	-4.4%	6'-6"	
10	23+00.04	17.31 LT	22+96.83	14.54 LT	5'-0"	5'-0"	4.3%	15'-0"	
11	23+39.24	19.88 LT	23+42.46	17.55 LT	8'-4"	5'-0"	4.3%	7'-8"	
12	17+74.43	21.00 LT	17+72.35	18.00 LT	6'-0"	6'-0"	4.1%	7'-6" B	
13	24+04.94	17.63 LT	24+08.05	15.26 LT	5'-0"	4'-0"	-4.1%	6'-6"	
18	32+44.12	17.81 LT	32+42.73	15.36 LT	6'-0"	4'-0"	-4.6%	6'-6"	
19	32+88.29	19.77 LT	32+91.37	17.03 LT	5'-6"	4'-0"	4.6%	15'-0"	


PEDESTRIAN CURB RAMP WITH CONTINUOUS DIRECTION OF PEDESTRIAN TRAVEL (ROUNDED CORNER)

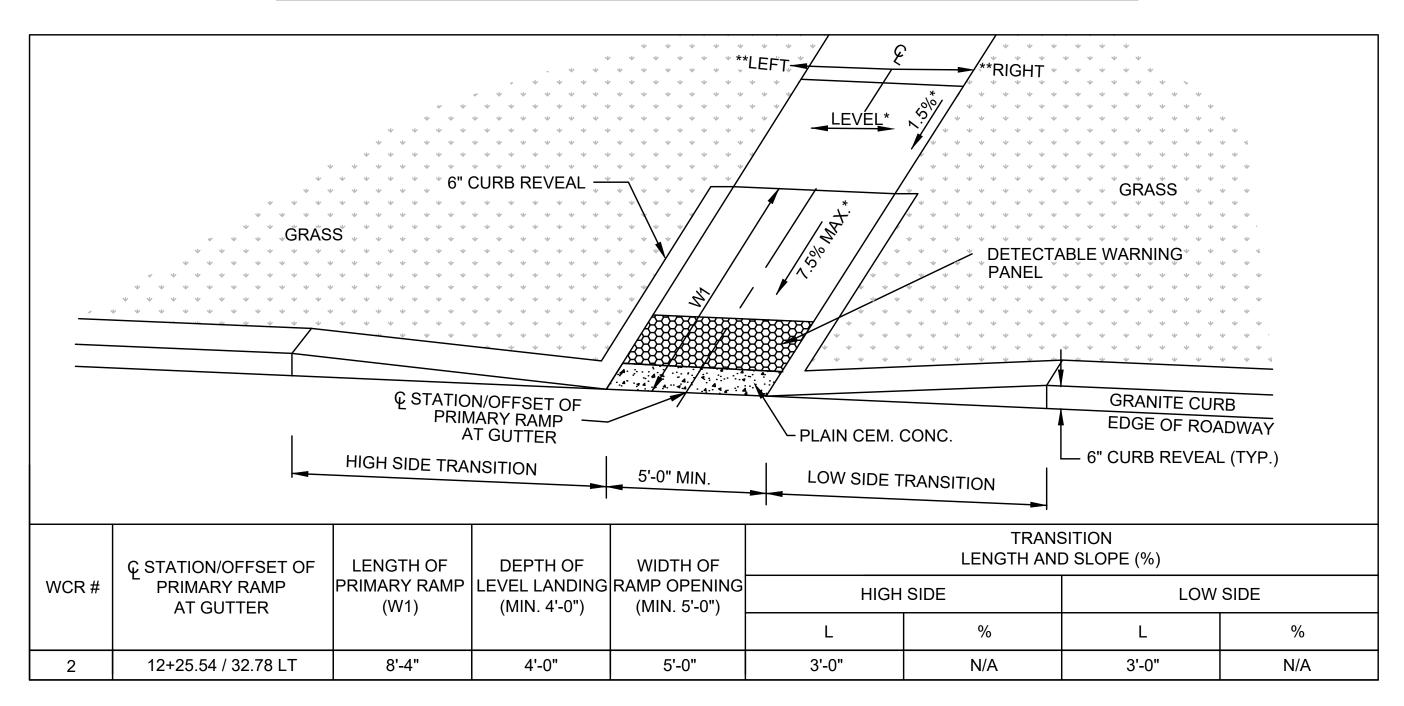


PEDESTRIAN CURB RAMP WITH CONTINUOUS DIRECTION OF PEDESTRIAN TRAVEL (GRASS)

CLIENT:	PROJECT:	PREPARED BY:		NO.	DATE	REVISION	SCALE:	NONE	DRAWING TITLE:	SHEET NO.
TOWN OF LUNENBURG	COMPLETE STREETS PROJECT	WORLDTECH					DATE:	MARCH 2021	PEDESTRIAN CURB	
17 MAIN STREET LUNENBURG, MA 01642	THREE LOCATIONS	ENGINEERING 300 TRADECENTER, SUITE 5580					WTE PROJ. NO:	20-019.01	RAMP AND	11 of 12
PHONE: 978-582-4144	LUNENBURG, MA	WOBURN, MA 01801 T: 781-933-4800					DESIGNED BY:	KMC	DRIVEWAY DETAILS	
		F: 781-933-4801	PROFESSIONAL CIVIL ENGINEER FOR WORLDTFCH FNGINFFRING. LLC				CHECKED BY:	TFQ		

WORLDTECH ENGINEERING, LLC

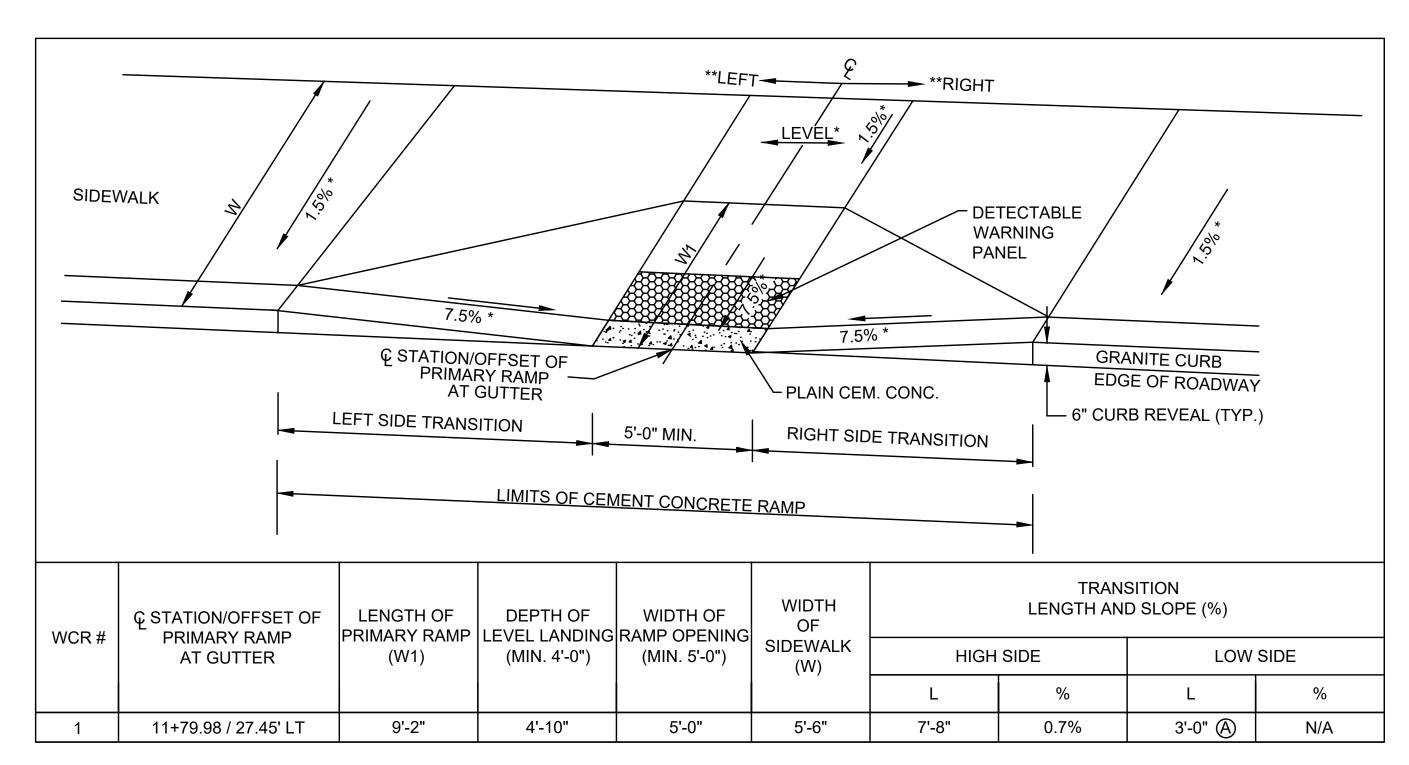

PEDESTRIAN CURB RAMP ON SIDEWALK WITH SIDEWALK WIDTH >12'-4"

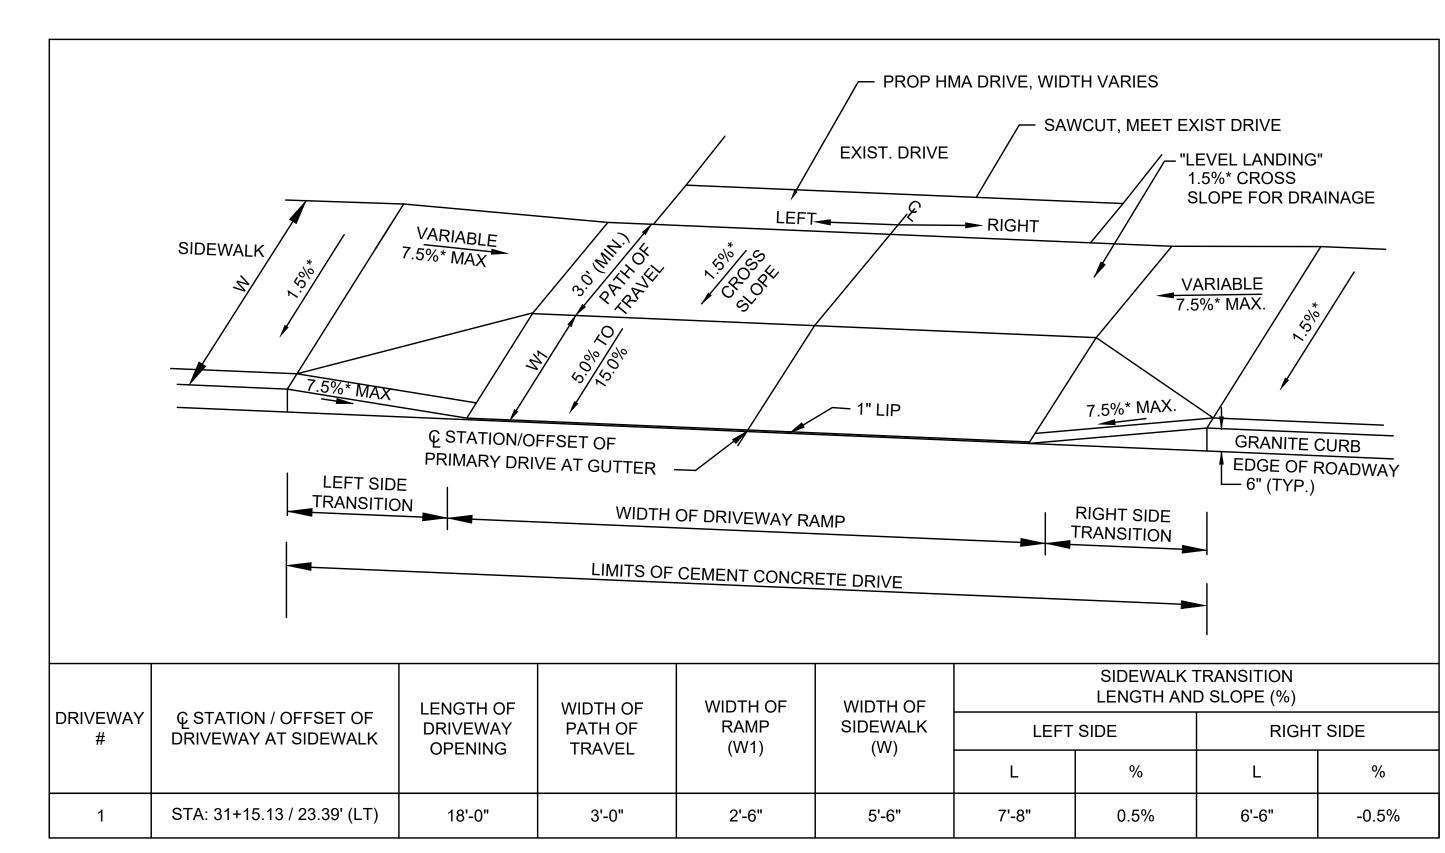

CEMENT CONCRETE SIDEWALK AT DRIVEWAYS

NOTES:

* CONSTRUCTION TOLERANCE ±0.5%.

(A) NO TRANSITION, 6" CURB REVEAL

DETECTABLE WARNING PANELS SHALL BE INCLUDED ON ALL PROPOSED PEDESTRIAN CURB RAMPS AS SHOWN IN THE MASSDOT CONSTRUCTION STANDARDS ISSUED IN OCTOBER 2017, DRAWING NO. E 107.6.5.

PROJECT:

® 3" CURB REVEAL

CLIENT:

TOWN OF LUNENBURG

17 MAIN STREET LUNENBURG, MA 01642 PHONE: 978-582-4144 COMPLETE STREETS PROJECT
THREE LOCATIONS
LUNENBURG, MA

PREPARED BY:

WIREPARED BY:

ENGINEERING

F: 781-933-4801

300 TRADECENTER, SUITE 5580 WOBURN, MA 01801 T: 781-933-4800

	NO.	DATE	REVISION	SCALE:	NONE
				DATE:	MARCH 2021
				WTE PROJ. NO:	20-019.01
				DESIGNED BY:	KMC
ROFESSIONAL CIVIL ENGINEER FOR WORLDTECH ENGINEERING, LLC				CHECKED BY:	TFQ

PEDESTRIAN CURB
RAMP AND
DRIVEWAY DETAILS